

## 2.5" - HOT MIX ASPHALT 12" DITCH. BOTH SIDES 4" - 3/4" CRUSHED WHERE CUT OCCURS ON AGGREGATE BASE 8" - 6" MINUS PIT RUN AGGREGATE SUBBASE

WEST DRIVEWAY CROSS SECTION

SCALE: NTS

- 1. ALL CONSTRUCTION SHALL BE PER 2020 EDITION OF IDAHO STANDARDS FOR PUBLIC WORKS CONSTRUCTION (ISPWC).
- 2. EXISTING CONDITIONS SITE TOPOGRAPHY PERFORMED BY LR GEO IN NOVEMBER OF 2020. EXISTING TOPOGRAPHY SHOWN IS BASED ON THIS SURVEY.
- CONTRACTOR SHALL AVOID DESTROYING OR DISRUPTING ALL MONUMENTS SHOWN OR OTHERWISE AND SHALL BE RESPONSIBLE FOR NOTIFICATION OF THE ENGINEER AND REPLACEMENT OF DISRUPTED OR DESTROYED MONUMENTS. AN IDAHO LICENSED LAND SURVEYOR SHALL REPLACE ALL MONUMENTS REMOVED OR DISTURBED BY CONSTRUCTION ACTIVITIES.
- EXISTING UTILITIES SHOWN HAVE BEEN LOCATED FROM FIELD SURVEY INFORMATION AND SURFACE OBSERVATIONS. ACTUAL LOCATIONS MAY DIFFER SUBSTANTIALLY FROM WHAT IS SHOWN. CONTRACTOR SHALL VERIFY EXISTING LOCATIONS PRIOR TO CONSTRUCTION. CONTRACTOR SHALL CALL DIGLINE PRIOR TO ANY EXCAVATION AT 208
- 342-1585. 5. CONTRACTOR IS RESPONSIBLE FOR OBTAINING ALL PERMITS AND INSPECTIONS AND FOR PAYING ASSOCIATED FEES.
- 6. CONTRACTOR SHALL STRIP A MINIMUM OF 6 INCHES (OR AS DIRECTED BY GEOTECHNICAL ENGINEER) OF ORGANIC SOIL MATERIAL FROM THE SURFACE OF THE
- SITE PRIOR TO PLACEMENT OF FILL MATERIAL OR EXCAVATION.
- 7. CONTRACTOR SHALL KEEP THE SUB GRADE SOILS DRY, UNFROZEN AND FREE OF TRAFFIC UNTIL UNTIL SUBSEQUENT FILL LEVELS HAVE BEEN PLACED AND COMPACTED. 8. ACCEPTABLE SOILS CLASSIFICATION GROUPS SW, GP, GM, SW, SP, AND SM OR A COMBINATION OF THESE GROUPS; FREE OF ROCK OR GRAVEL LARGER THAN 6 INCHES IN ANY DIMENSION, DEBRIS, WASTE, FROZEN MATERIALS, VEGETATION, AND OTHER DELETERIOUS MATTER, AND AS APPROVED BY THE GEOTECHNICAL ENGINEER MAY BE
- USED AS STRUCTURAL FILL MATERIAL. 9. THE STRIP MATERIAL WHICH CANNOT BE USED AS STRUCTURAL MATERIAL, I.E. GREATER
- THAN 3% ORGANICS, MAY BE USED AS LANDSCAPE FILL MATERIAL. 10. THE AREA TO RECEIVE FILL SHALL BE SCARIFIED TO PROVIDE A BOND WITH THE NEW FILL. FILL SHALL NOT BE PLACED UNTIL THE AREA IS PREPARED BY CONSTRUCTING A LEVEL OR SLIGHTLY IN-SLOPED TOE BENCH INTO COMPETENT MATERIAL AT THE BASE OF THE NEW FILL. EXISTING SLOPES (GREATER THAN 12:1) GROUND SURFACES SHALL BE PREPARED BY TERRACING GROUND WITH 5 FOOT WIDE "SHELVES" PRIOR TO BACKFILLING.

- 11. PLACE BACKFILL AND FILL SOIL MATERIALS IN LAYERS NOT MORE THAN 8 INCHES IN LOOSE DEPTH FOR MATERIAL COMPACTED BY HEAVY COMPACTION EQUIPMENT, AND NOT MORE THAN 4 INCHES IN LOOSE DEPTH FOR MATERIAL COMPACTED BY HAND-OPERATED TAMPERS. COMPACT SOIL MATERIALS TO NOT LESS THAN THE FOLLOWING PERCENTAGES OF MAXIMUM DRY DENSITY ACCORDING TO ASTM D 1557: EXCAVATED ONSITE OR IMPORTED SOIL FILL, 90%; SUBGRADE, 90%; AGGREGATE BASE AND SUBBASE, 95%; UTILITY TRENCHES, 90%. UNDER LAWN OR UNPAVED AREAS, SCARIFY AND RE COMPACT TOP 6 INCHES BELOW GRADE AND COMPACT EACH LAYER
- OF BACKFILL OR FILL SOIL MATERIAL TO 85 PERCENT. 12. PROPOSED SLOPES SHALL NOT EXCEED 2:1.
- 13. EXISTING PAVEMENT TO REMAIN SHALL BE PROTECTED FROM DAMAGE. ALL HEAVY VEHICLE TRAFFIC SHALL BE KEPT OFF OF EXISTING PAVEMENT AS MUCH AS POSSIBLE. 14. TESTING OF COMPACTION AND APPROVAL OF CUT AND FILL SLOPES BY THE GEOTECHNICAL ENGINEER IS REQUIRED!!.
- 15. HYDRO SEED WITH CLIMATE TOLERANT POLLINATOR MIX ALL DISTURBED AREAS. OBTAIN MIX DESIGN FROM OWNER.

INVERT ELEV. LIP OF GUTTER LOW POINT MATCH EXISTING FINISHED FLOOR RIM ELEVATION TOP OF CURB TOP OF SLAB FLOW LINE TS **GRADE BREAK** TW TOP OF WALL

PROPERTY LINE

**EXISTING CONTOUR** (1.0' INTERVALS)

**HIGH POINT** 

PROPOSED CONTOUR (0.5' INTERVALS)

CUT LIMITS -----

FILL LIMITS

## **KEYNOTES:**

EXISTING SURVEY MONUMENTS TO BE RETAINED AND PROTECTED. CONTRACTOR SHALL HAVE A LICENSED SURVEYOR LOCATE AND MARK ALL EXISTING MONUMENTS PRIOR TO CONSTRUCTION. ANY MONUMENT DISTURBED BY CONSTRUCTION ACTIVITIES SHALL BE REPLACED BY A LICENSED LAND SURVEYOR AT THE EXPENSE OF THE CONTRACTOR. (FP = FINAL PLAT PINS)

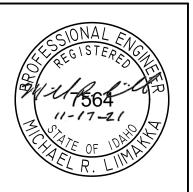
 $\langle 2 \rangle$  BENCH MARK: TBM, MAG NAIL = 2622.28

- $\langle$  3 angle EXISTING A.C. PAVEMENT. RETAIN AND PROTECT.
- 4 PROPOSED SHOP AND RESIDENCE.
- $\langle 5 \rangle$  FUTURE BUILDING PAD.
- APPROXIMATE LOCATION OF PROPOSED SEPTIC DRAINFIELD (6) AND REPLACEMENT AREA. LOCATE IN ACCORDANCE WITH THE 2019 GUIDANCE MANUAL AND CENTRAL DISTRICT HEALTH DEPARTMENT REQUIREMENTS.
- CONSTRUCT FILL SLOPES. MAXIMUM 2:1 SLOPES, SPREAD SMOOTHLY AND STABILIZE WITH HYDROSEED.
- CONSTRUCT CUT SLOPES. MAXIMUM 2:1 SLOPES. STABILIZE WITH HYDROSEED.
- $\langle$  9 angle construct mild drainage ditch around residence.
- $\langle 10 
  angle$  existing adjacent lot driveway.
- $\langle 11 \rangle$  Install rock check dams per ideq BMP 22.
- $\langle 12 
  angle$  existing transformer. Retain and protect.
- $\langle 13 \rangle$  Existing underground power. Retain and protect.
- $\langle 14 \rangle$  INSTALL 12" CMP CULVERT, LENGTH PER PLAN. INVERTS AS REQUIRED. 12" MINIMUM COVER.
- $\langle 15 \rangle$  NOT USED.
- $\langle 16 \rangle$  CONSTRUCT ASPHALT DRIVEWAY PER DETAIL 2, SHEET C1.0.
- CONSTRUCT DRIVEWAY APPROACH PER ACHD DETAIL SD-809, SHEET C1.3.
- 18 INSTALL FIRE TRUCK TURNAROUND OR HAMMER HEAD PER DETAIL 5, SHEET C1.3.
- APPROXIMATE LOCATION OF PROPOSED WELL WITH 100'
- $\overline{\langle 20 \rangle}$  Construct infiltration basin per city of eagle SD-04.
- $\langle 21 \rangle$  PROPOSED BOULDER WALL.
- $\langle 22 \rangle$  CONSTRUCT SAND WINDOW PER DETAIL 4, SHEET C1.3.
- $\langle 23 \rangle$  CONSTRUCT GRAVEL DRIVEWAY PER DETAIL 2, SHEET C1.2.
- $\langle 24 \rangle$  NOT USED.
- (25) INSTALL ROCK LINED DRAINAGE DITCH TO BASIN PER DETAIL 3, SHEET C1.3.

Volume Summary				
Cut Factor	Fill factor	<b>Cut</b> (Cu. Yd.)	<b>Fill</b> (Cu. Yd.)	<b>Net</b> (Cu. Yd.)
1.00	1.00	4022 CY	4165 CY	143 CY FILL

\*\*THIS ESTIMATE IS PROVIDED FOR INFORMATIONAL PURPOSES ONLY. QUANTITIES SHOWN REPRESENT A COMPARISON OF THE FINISHED GRADE SURFACE WITH THE EXISTING GROUND SURFACE AND CONSIDER NO SHRINKAGE. CONTRACTOR SHOULD VERIFY QUANTITIES ON HIS OWN.

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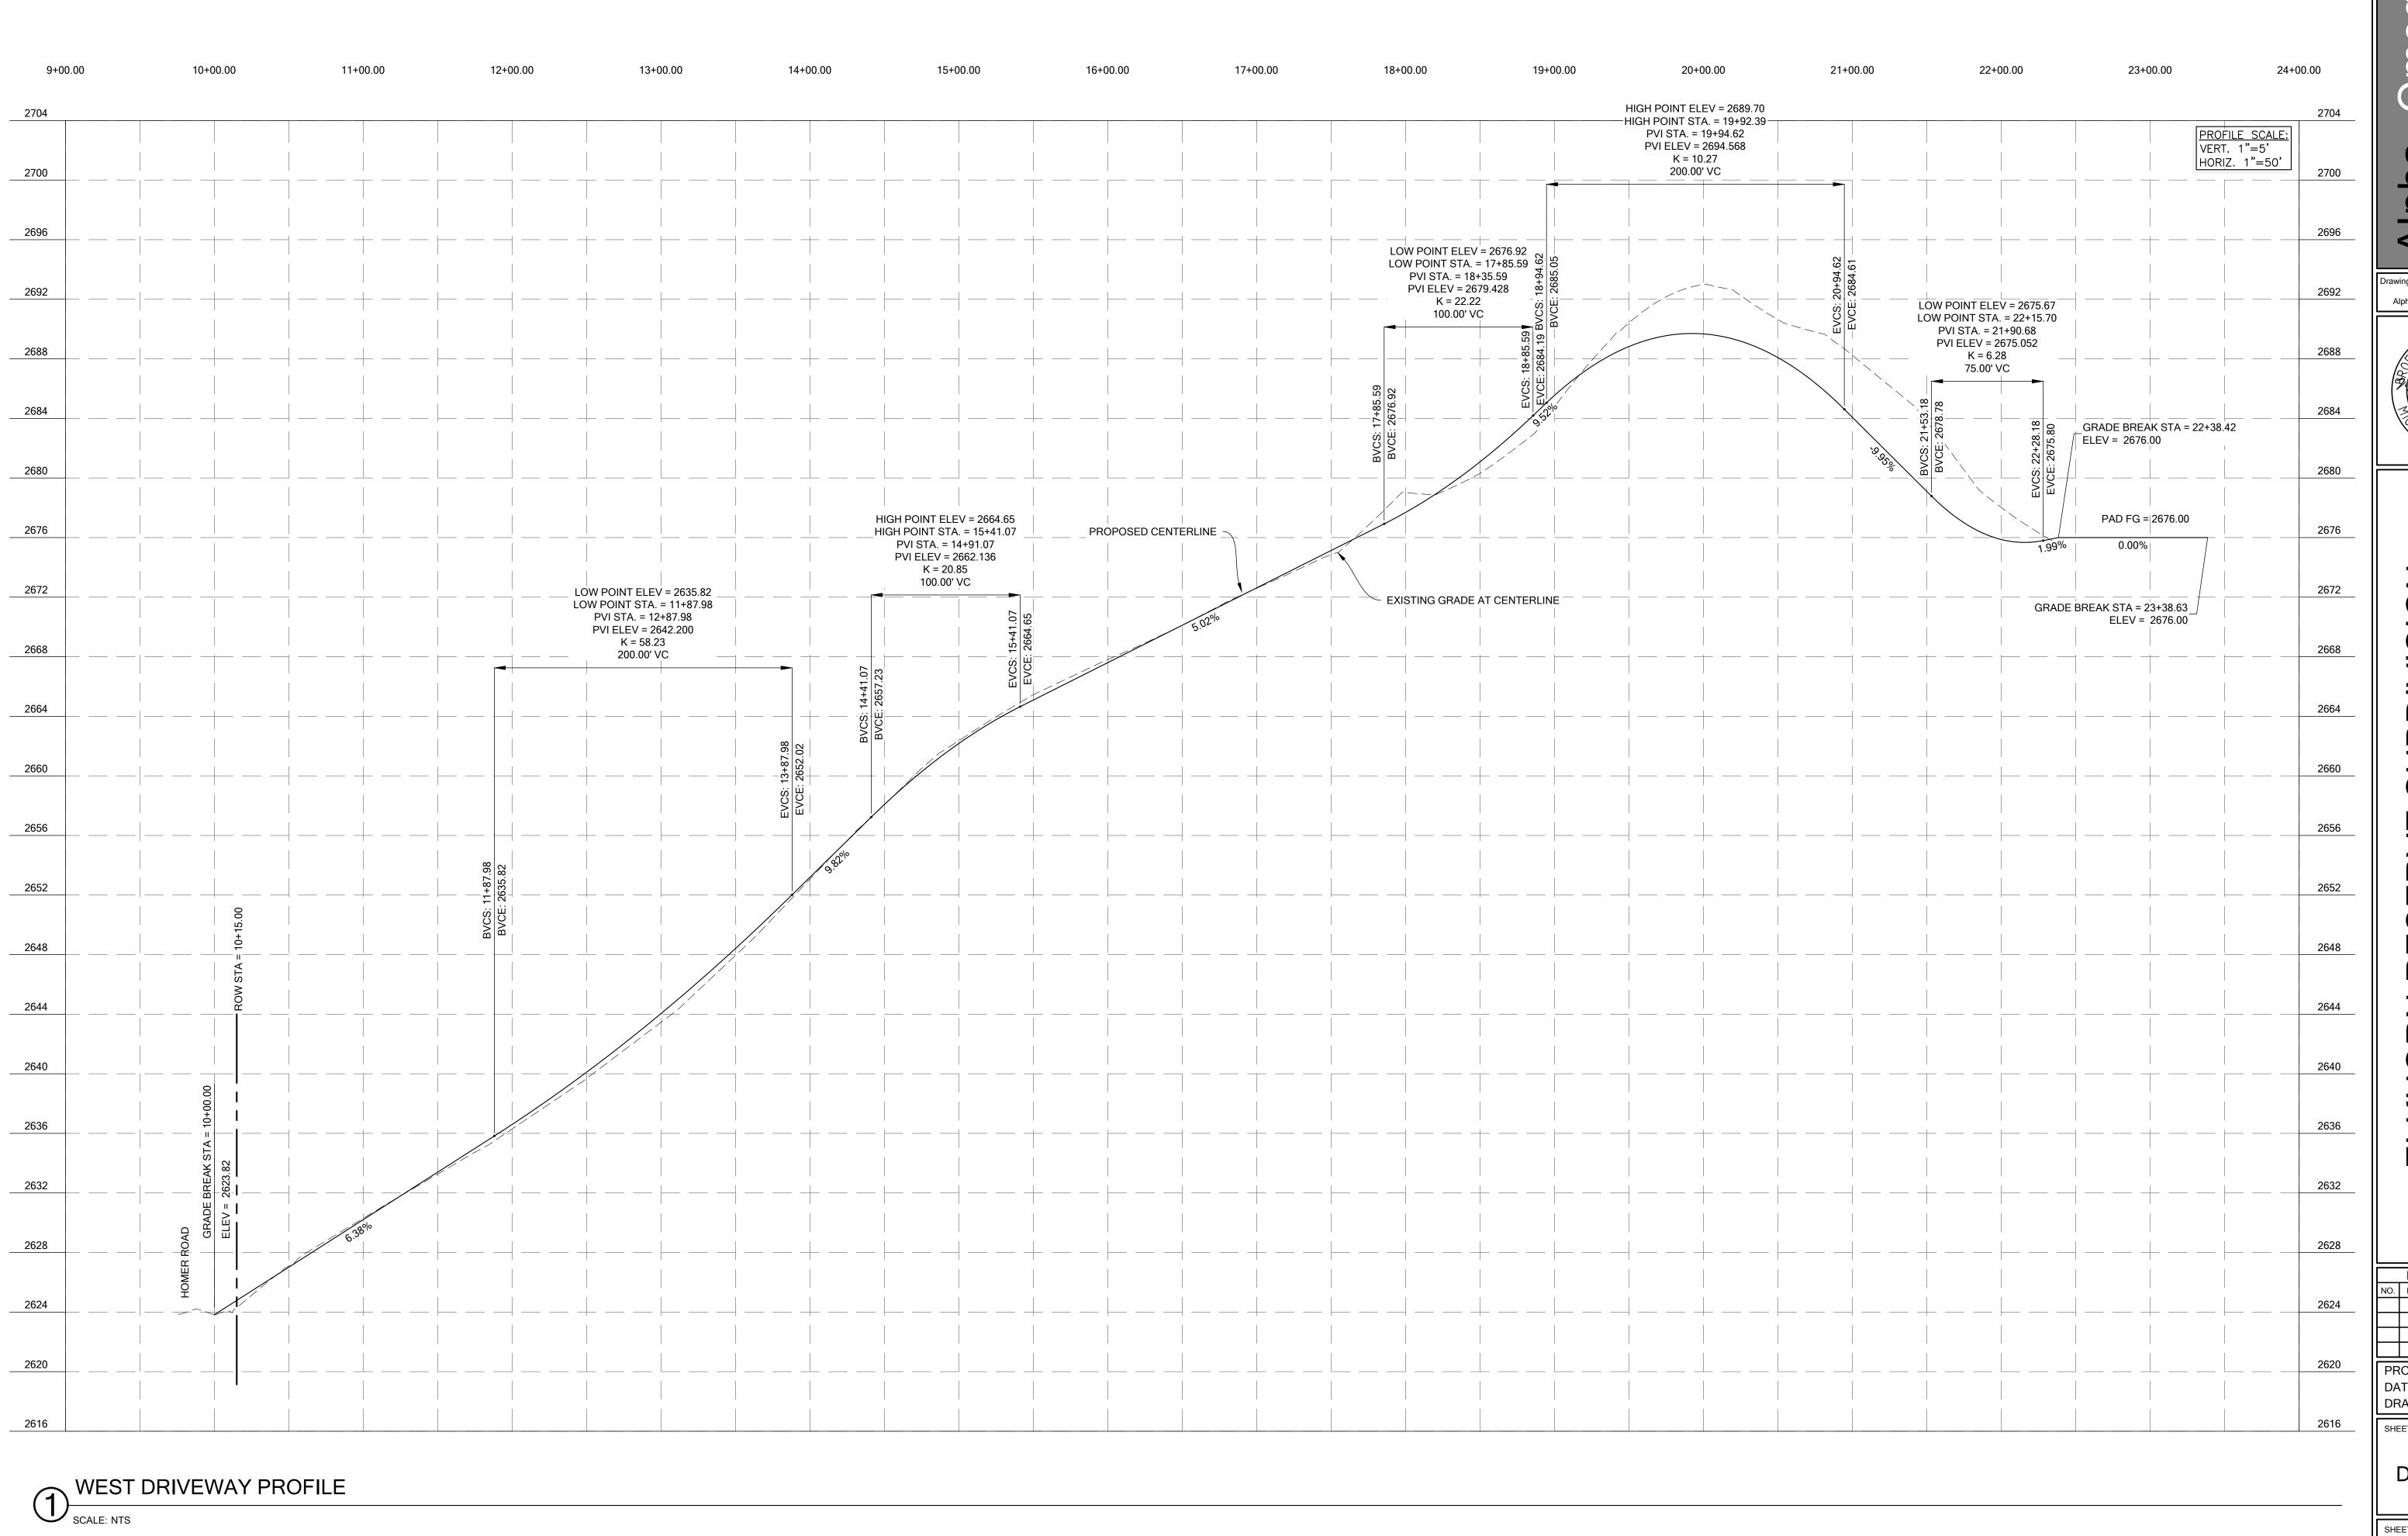
PROJECT #: DATE: 11-17-21

**DRAWN BY:** 

**GRADING PLAN** 

SHEET NO.:

SHEET TITLE:



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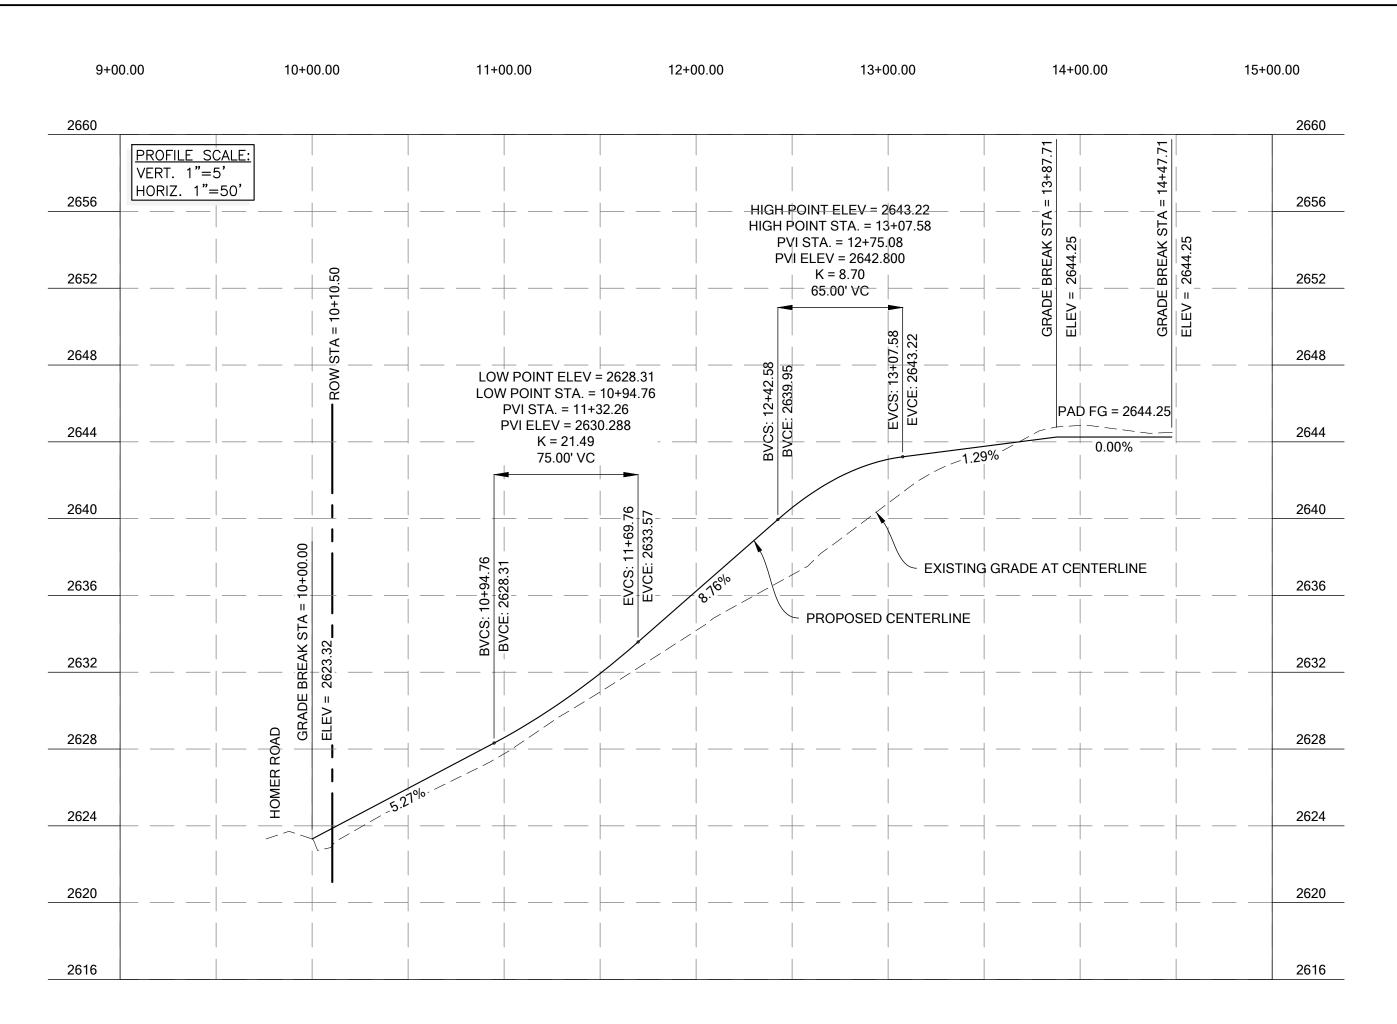
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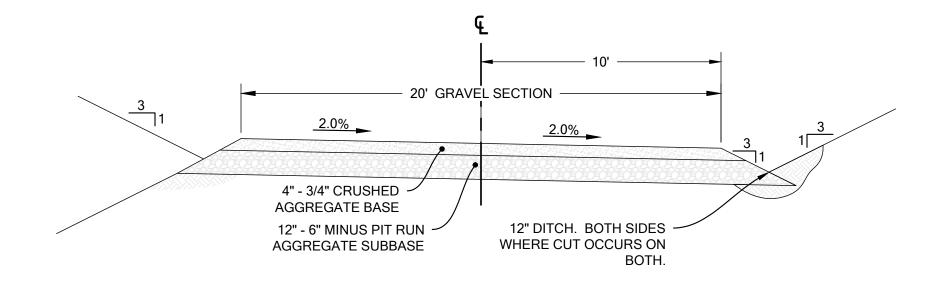
WEST DRIVEWAY PROFILE





EAST DRIVEWAY PROFILE

SCALE: NTS




EAST DRIVEWAY CROSS SECTION

SCALE: NTS

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SHEET TITLE: EAST DRIVEWAY PROFILE



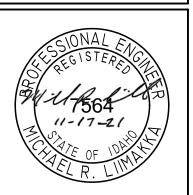

## LOT 2 DRIVEWAY GRADING (CONCEPTUAL) SCALE: 1" = 10'

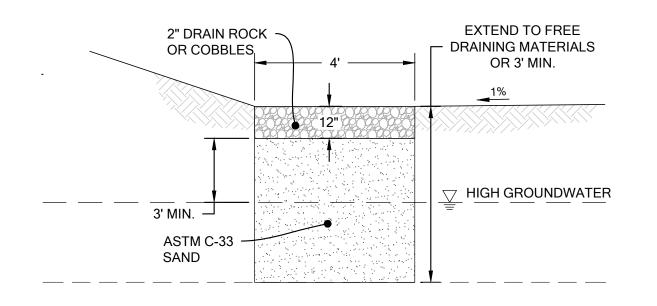
ROCK SHOULD BE INSTALLED FLUSH WITH SWALE SLOPES

FLATTEN AT BASIN

6" RIVER ROCK


8" DEEP - 6" MAX. TO 3" MIN. NOMINAL COBBLE.

## ROCK LINED DRAINAGE CHANNEL SCALE: NTS




SAND WINDOW

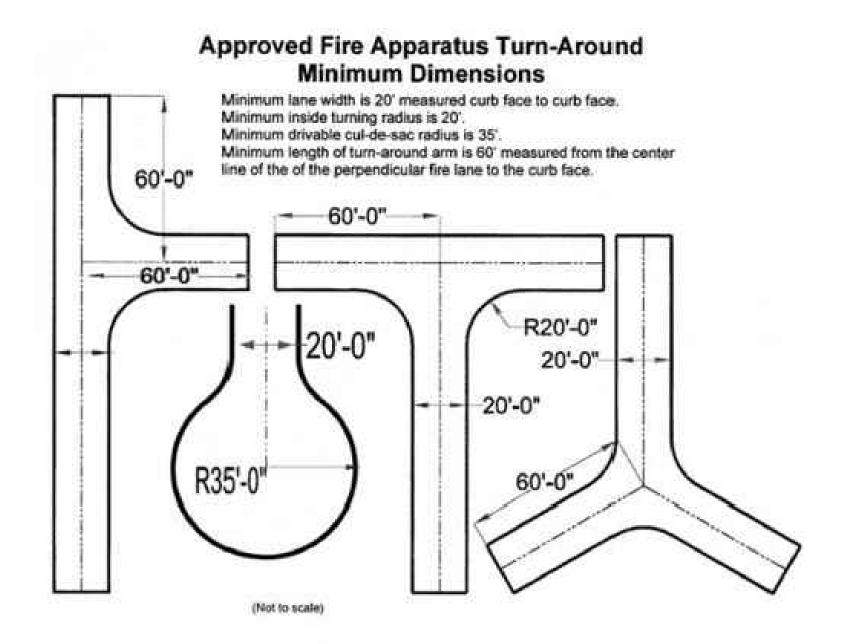
SCALE: NTS




STAR FIRE HAMMERHEADS AND TURNAROUNDS

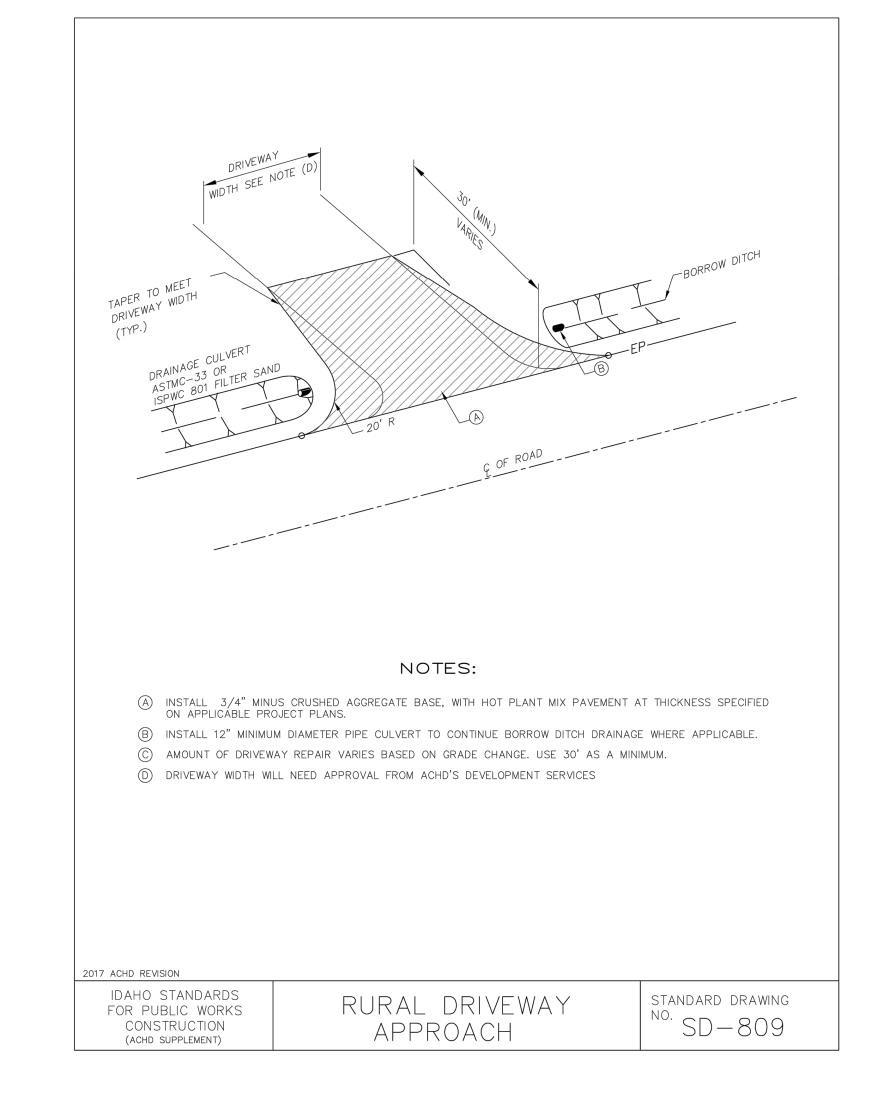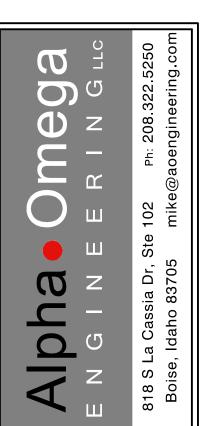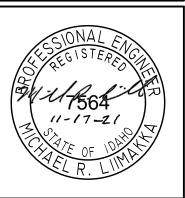SCALE: NTS





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